5 PPG LOBBY RENOVATION



PROJECT No. 396

LANDLORD

HIGHWOODS PROPERTIES INC. 200 THREE PPG PLACE PITTSBURGH, PA 15222 PHONE: (412) 773-8173

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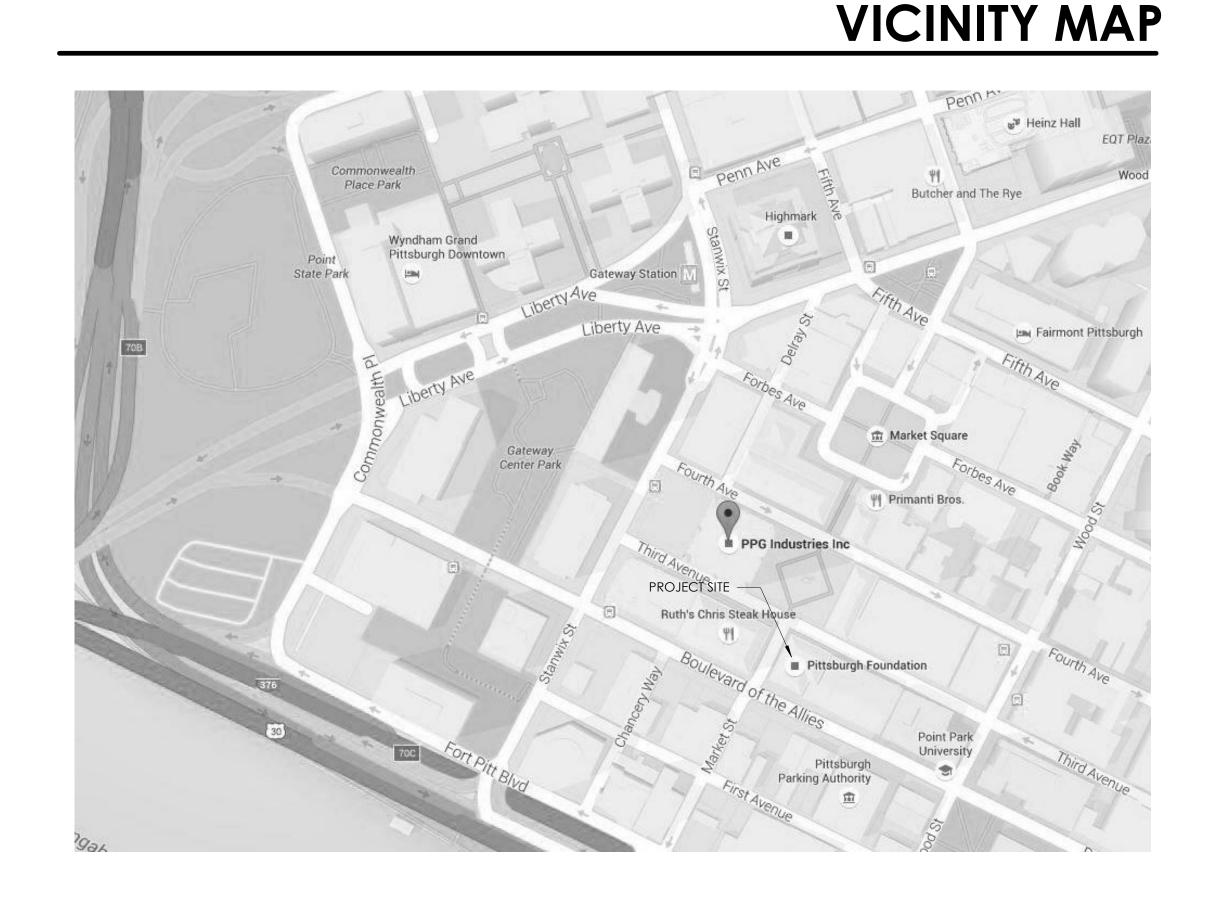
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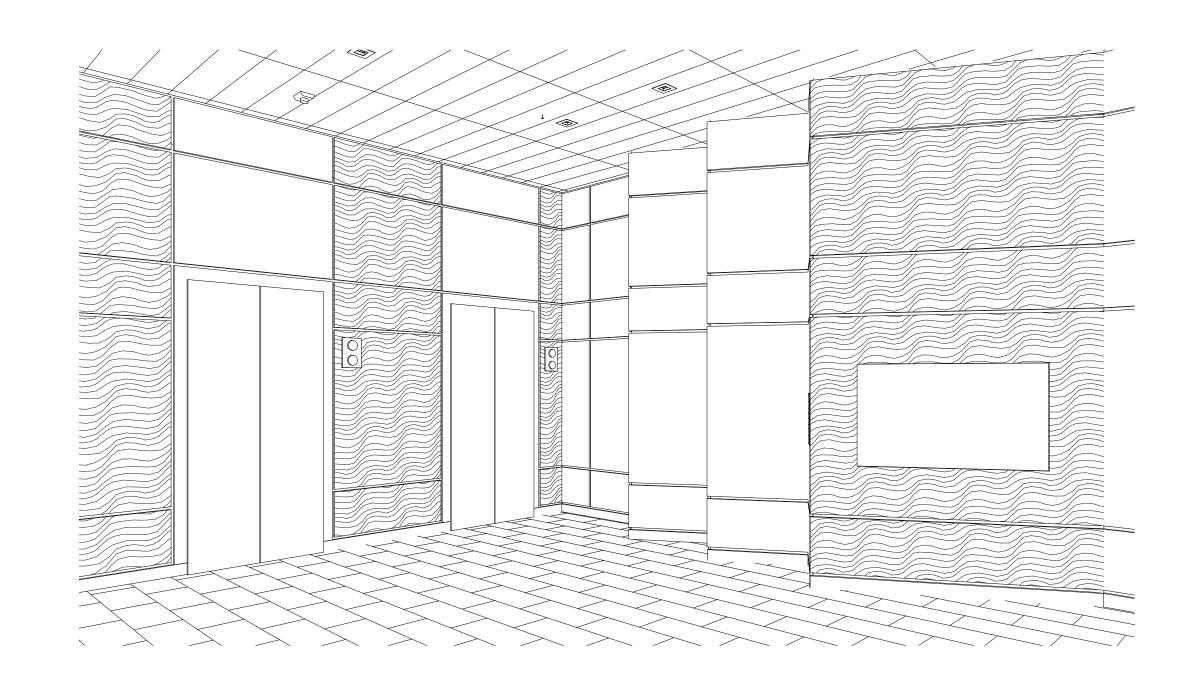
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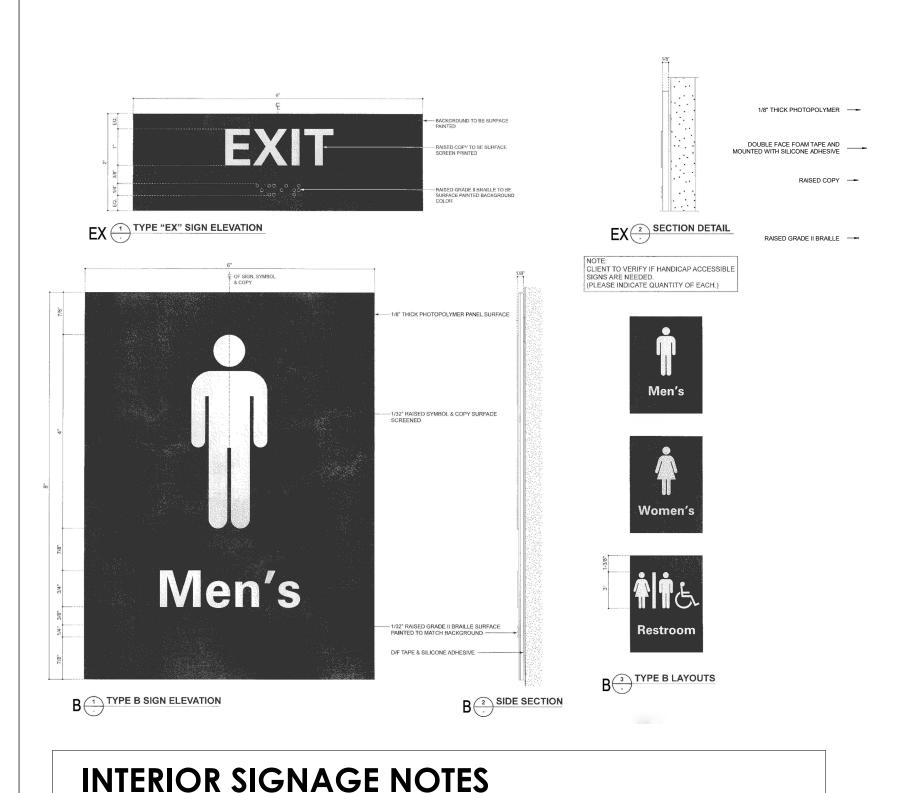
COVER SHEET

G001



ISOMETRIC VIEW





MOUNTING HEIGHTS (PER ICC/ANSI A117.1-2009 SECTION 703.3.10):

A.F.F. MEASURED TO THE BASELINE OF THE HIGHEST TACTILE CHARACTER.

PROVIDE SIGNS ALONGSIDE THE DOOR AT THE LATCH SIDE.

LOCATE SIGNS AT DOUBLE DOORS WITH ONE ACTIVE LEAF ON THE INACTIVE LEAF.

SIGNAGE LOCATIONS (PER ICC/ANSI A117.1-2009 SECTION 703.3.11):

DOUBLE DOORS ON THE NEAREST ADJACENT WALL.

MOUNT ALL SIGNAGE W/ TAMPER RESISTANT FASTENERS.

AND 45 DEGREE OPEN POSITION.

GENERAL CONDITIONS FOR PROJECT

- 1. INSTALL ALL WORK INDICATED IN ACCORD WITH APPLICABLE CODES, ORDINANCES, AND REGULATIONS OF ALL AUTHORITIES HAVING JURISDICTION. WHERE A CONFLICT ARISES BETWEEN PLANS, SPECIFICATIONS, DETAILS, SCHEDULES AND APPLICABLE CODES OR REGULATIONS, THE MOST STRINGENT OF THE TWO APPLES.
- 2. VISITS THE SITE TO DETERMINE EXITING CONDITIONS. THE LANDLORD WILL NOT CONSIDER AND CHANGES TO THE CONTRACT FOR FAILING TO MEET THIS REQUIREMENT.
- 3. OBTAINS AND PAYS FOR ALL REQUIRED PERMITS, LICENCE, AND INSPECTION FEES FOR THE WORK INDICATED.
- 4. WARRANTY: FOR ALL MATERIALS, EQUIPMENT AND LABOR FOR A PERIOD OF ONE YEAR AFTER SUBSTANTIAL COMPLETION.
- ALL MATERIALS AND EQUIPMENT PROVIDED FOR THE PROJECT ARE NEW. 6. THE DRAWINGS ARE DIAGRAMMATIC, VERIFY ACTUAL CONDITIONS AT THE SITE BEFORE
- PROCEEDING WITH ANY WORK. 7. COORDINATE ALL WORK WITH OTHER TRADES AND EXISTING CONDITIONS
- 8. HIDDEN AND LATENT CONDITIONS: NOTIFY THE LANDLORD AND ARCHITECT BEFORE PROCEEDING WITH ANY WORK THAT, THROUGH THE COURSE OF THE CONSTRUCTION AND CONDITION IS EXPOSED OR NOT REASONABLY VISIBLE DURING A WALK THROUGH OR INDICATED ON THE CONTRACT DOCUMENTS. FAILURE TO NOTIFY THE ARCHITECT WILL MAKE THE CONTRACTOR RESPONSIBLE FOR ALL COSTS AND CONSEQUENCES OF SUCH FAILURE.
- 9. COORDINATE WITH THE LANDLORD TO SCHEDULE ANY INTERRUPTION OF ANY BUILDING UTILITY 24 HOURS PRIOR TO COMMENCEMENT OF THE NECESSARY INTERRUPTION. 10. EXISTING STRUCTURE IS PROTECTED BY SPRAY APPLIED FIRE PROOFING. PROTECT AND PRESERVE ALL EXISTING FIREPROOFING. COMPLETELY PATCH AND REPAIR ANY DAMAGE

INCURRED DURING THE EXECUTION OF THE WORK.

PROJECT SUMMARY

PROJECT ADDRESS: 5 PPG PLACE, PITTSBURGH, PA 15222

BLOCK AND LOT NO. : I-H-30

ZONING G - TA GOLDEN TRIANGLE DISTRICT A

OCCUPANCY TYPE : B - BUSINESS

CONSTRUCTION TYPE : (1A - FULLY PROTECTED

FIRE PROTECTION FULLY ADDRESSABLE FIRE ALARM SYSTEM THROUGHOUT <NFPA 72>

> SPRINKLER SYSTEM THROUGHOUT <NFPA 13>. FIRE ALARM SYSTEMS AND SPRINKLERS REMAIN AS INSTALLED WITH NO WORK SCHEDULED. STANDARD PROTECTIONS FOR

EXISTING DEVICES DURING CONSTRUCTION.

APPLICABLE CODES INTERNATIONAL BUILDING CODE 2015

> CHAPTER 11 OF INTERNATIONAL BUILDING CODE 2018 ICC A117.1-2009

AMERICANS WITH DISABILITIES ACT

NFPA 72, NFPA 13, NFPA 10 INTERNATIONAL ENERGY CONSERVATION CODE 2015, CHAPTER 4, TABLE 402.1.3 AND TABLE 402.4 FOR NEW GLAZING

HNTERNATIONAL PLUMBING CODE 2015 ALLEGHENY COUNTY PLUMBING CODE

IEBC DESCRIPTION CHAPTER 3 PROVISIONS FOR ALL COMPLIANCE METHODS,

SECTION 301.1.1 PRESCRIPTIVE COMPLIANCE METHODS CHAPTER 4 SECTION 403 ALTERATIONS, 403.1 GENERAL

PESCRIPTIVE COMPLIANCE ET. SEQ. EXISTING BUILDING AND STRUCTURE IS IMPROVES

BY PROVIDING NEW GLAZING SYSTEM AND FULLY THERMALLY BROKEN GLAZING

SYSTEM.

SECTION 504, ALTERATIONS LEVEL 2, SECTION 504.2 APPLICATION, CHAPTER 7 AND 8

FOR LEVEL 1 AND 2, CHAPTER 8, LEVEL 2 ET.SEQ.


SQUARE FOOTAGE OF WORK, AREA: 625FT² **SCOPE OF WORK**

OCEUPANCY TYPE AND OCCUPANCY COUNT UNCHANGED


INTERIOR UPGRADES, FLOORING, NEW CEILING AND REPLACEMENT OF EXISTING


STOREFRONT SYSTEM & NEW BUILDING SIGNAGE

TACTILE CHARACTERS: 48" MIN. A.F.F., MEASURED TO THE BASELINE OF THE LOWEST TACTILE CHARACTER AND 60" MAX. LOCATE SIGNS AT DOUBLE DOORS WITH TWO ACTIVE LEAFS TO THE RIGHT OF THE RIGHT HAND DOOR. LOCATE SIGNS WHERE THERE IS NO WALL SPACE ON THE LATCH SIDE OF A SINGLE DOOR OR THE RIGHT SIDE OF LOCATE SIGNS WITH TACTILE CHARACTERS SO THAT A CLEAR FLOOR AREA OF 18"X18" MIN. CENTERED ON THE TACTILE CHARACTERS, IS PROVIDED BEYOND THE ARC OF ANY DOOR SWING BETWEEN THE CLOSED POSITION

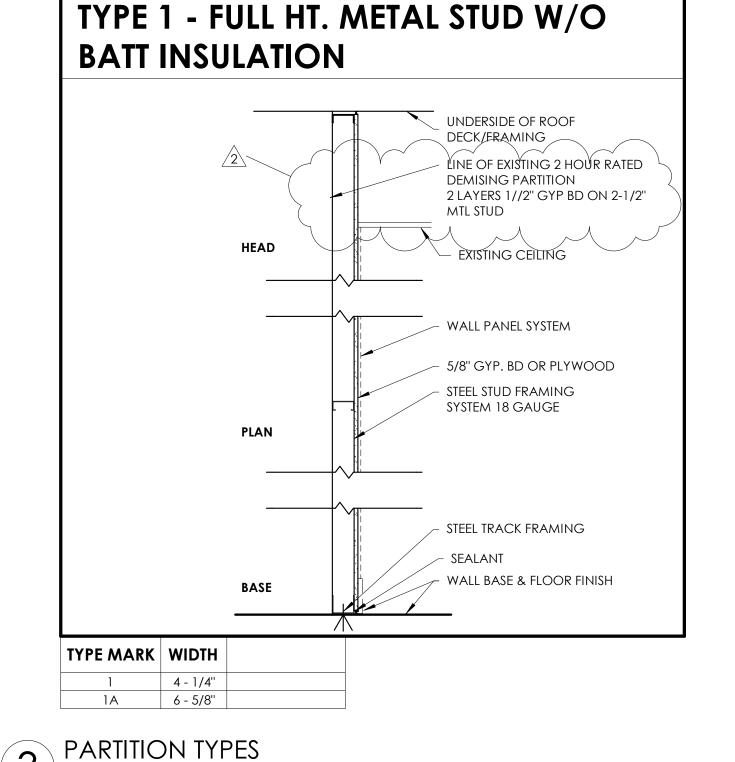


3/4" = 1'-0"

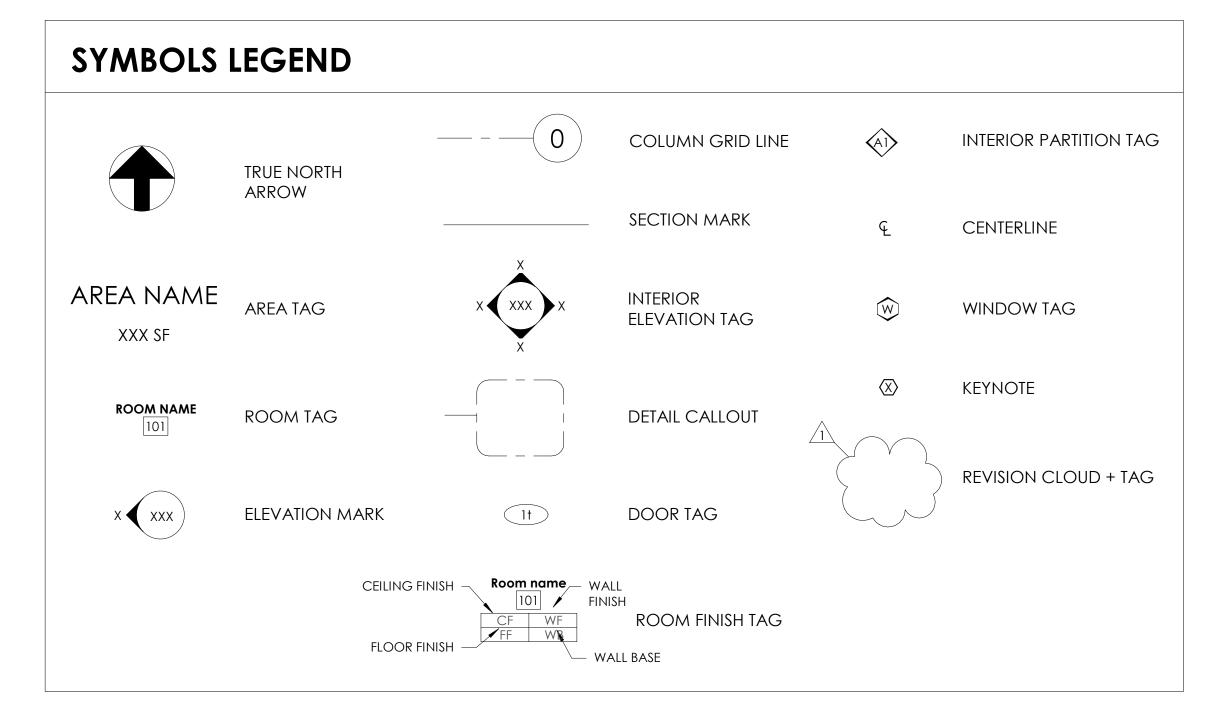

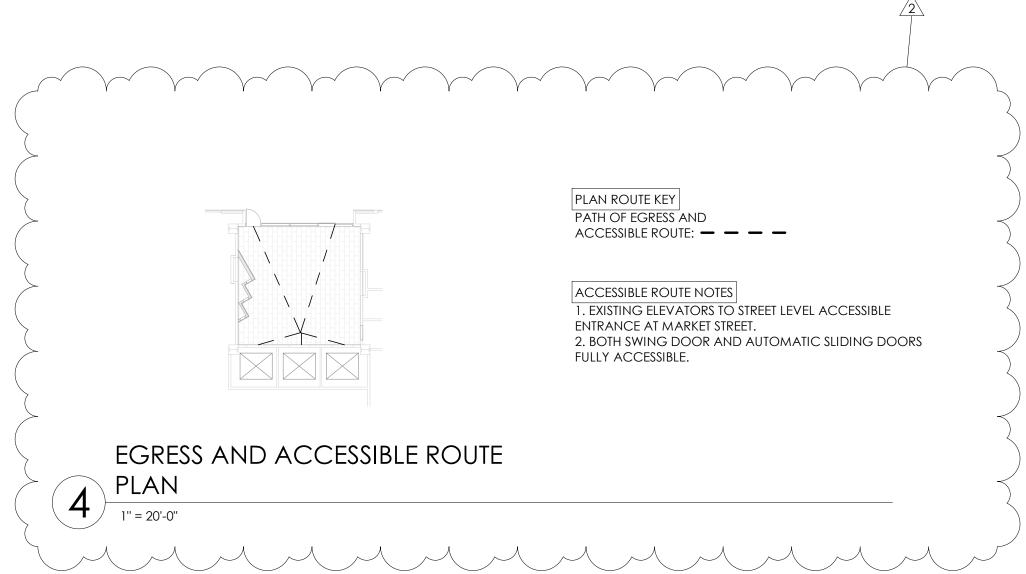



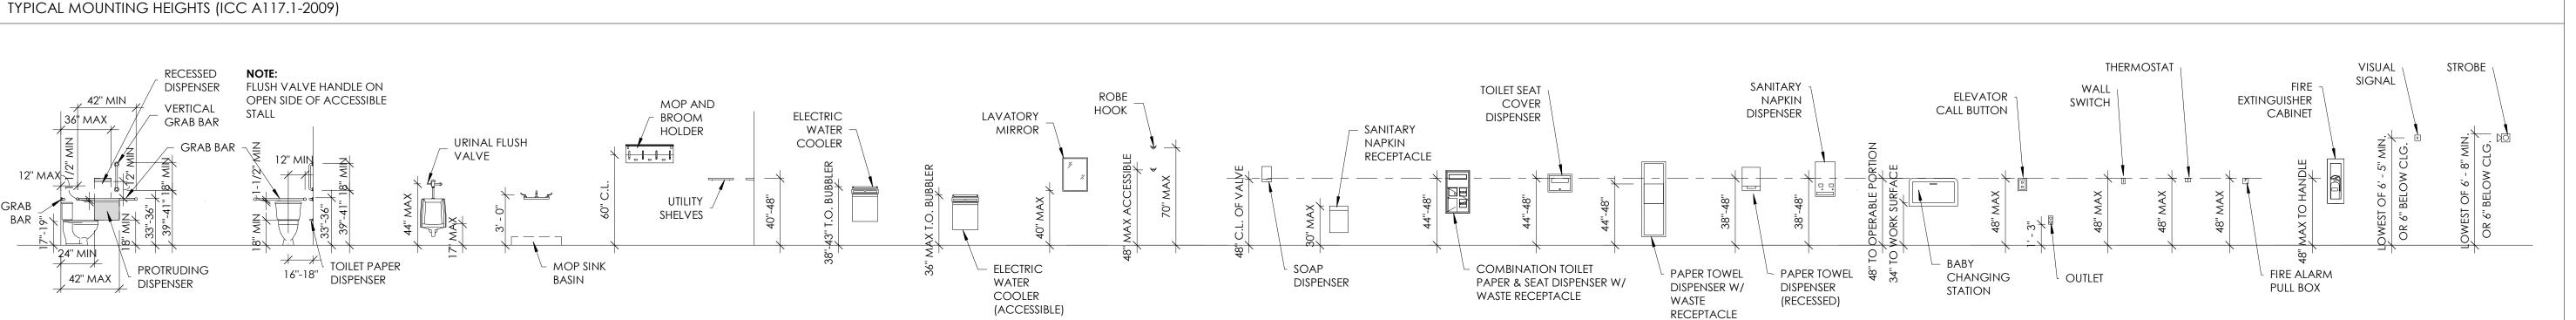



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PLI COMMENTS

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5 PPG LOBBY RENOVATION

5 PPG PLACE PITTSBURGH, PA 15222

PROJECT NO. 01/15/2021 **ISSUE DATE** SHEET TITLE GENERAL CODE **REVIEW &** SUMMARY

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4 REMOVE STOREFRONT BELOW SIGN BAND. 5 SALVAGE SWING DOOR. 6 REMOVE SLIDING DOOR. 7 REMOVE & SALVAGE TELECOM DEVICES AND CARD READER 8 REMOVE & SALVAGE STONE FOR REINSTALLTION. 9 SALVAGE EXISTING ALUMINUM CLADDING. 10 SALVAGE EXISTING SIGNAGE PANEL ABOVE AND PREP FOR NEW SIGN BAND. 11 REMOVE & DISPOSE OF LIGHT FIXTURES. 12 REMOVE & DISPOSE OF SECURITY DESK. 13 REMOVE & SALVAGE EXISTING MAILBOXES. 14 REMOVE & DISPOSE OF DIRECTORY. REMOVE & DISPOSE OF GRANITE WALL PANELS & FASTENER SYSTEMS AT ALL WALLS WITH DOORS OR 16 REMOVE & SALVAGE ELEVATOR LANTERNS FOR RELOCATION TO WALL FACE.

DEMOLITION PLAN

CODED NOTES - DEMOLITION

3 REMOVE & DISPOSE OF CERAMIC CEILING TILE SYSTEM AND PREP FOR NEW CEILING.

1 REMOVE STOREFRONT BELOW SIGN BAND.

2 REMOVE REVOLVING DOOR.

GENERAL NOTES - DEMOLITION

- PROTECT & MAINTAIN EXISTING WINDOWS, DOORS, & FLOORS FROM DAMAGE DURING
- PROTECT & MAINTAIN EXISTING CENTRAL AIR SYSTEM DUCTWORK FROM AIRBORNE DEBRIS
- DURING DEMOLITION.
 DRAWINGS ARE INTENDED AS A GENERAL GUIDE TO THE DEMOLITION REQUIRED FOR THIS
- DRAWINGS ARE INTENDED AS A GENERAL GUIDE TO THE DEMOLITION REQUIRED FOR TI PROJECT AND ARE NOT SHOWN IN COMPLETE DETAIL.
- COORDINATE REMOVAL OF EXISTING CONSTRUCTION REQUIRED FOR THE NEW CONSTRUCTION INDICATED OR FOR WORK REASONABLY IMPLIED FOR CONSTRUCTION.
 REMOVE, PATCH, AND REPAIR LATENT AND UNFORESEEN CONDITIONS FOUND WITHIN EXISTING
- CONSTRUCTION THAT INTERFERE WITH THE WORK INDICATED.

 6. NOTIFY ARCHITECT AND OWNER FOR ITEMS INCLUDING, BUT NOT LIMITED TO LATENT AND
- UNFORESEEN /UNKNOWN CONDITIONS AND FOR ITEMS NOT SHOWN/LISTED ON THE ARCHITECTURAL,
- 7. MECHANICAL, ELECTRICAL, AND PLUMBING DRAWINGS. COORDINATE WITH THE ARCHITECT BEFORE REMOVING THE ABOVE MENTIONED ITEM.
- 8. REMOVE ALL ABANDONED CONDUIT, DUCTWORK, HANGERS, CEILING TILE, GRID, FRAMING, PIPING, ETC. THROUGHOUT WORK AREA. RELOCATE EXISTING J-BOXES, SWITCHES, ETC. THAT ARE BEING REUSED AND REQUIRED TO BE MOVED TO ACCOMMODATE NEW WALL CONSTRUCTION
- PATCH AND PAINT (CORNER TO CORNER) ALL SURFACES OF EXISTING INTERIOR PARTITIONS THAT
- ARE NOT BEING DEMOLISHED OR WERE DAMAGED DUE TO THE DEMOLITION PROCEEDINGS.

 10. VERIFY EXISTING CONDITIONS AND DIMENSIONS PRIOR TO BEGINNING ANY WORK. NOTIFY THE ARCHITECT IN WRITING OF DISCREPANCIES FOR RESOLUTION PRIOR TO THE BEGINNING OF ANY
- 11. WORK.

 12. WHERE SMALL AREAS OF CEILING ARE AFFECTED BY DEMO OR ARE ADJACENT TO EXISTING
- CEILINGS; REPAIR ADJOINING CEILINGS WITH MATCHING MATERIAL AND FINISH.

 13. REMOVE WALLS, WALL FURRING, DOORS, FRAMES, ETC. THROUGHOUT THE AREA TO FACILITATE
- NEW CONSTRUCTION AS SHOWN IN THE CONSTRUCTION DOCUMENTS.


 14. PROVIDE NEW CEILING(S) AS SHOWN. REMOVE BRACING, SUPPORTS HANGERS, FOR THE
- INSTALLATION NEW GYPSUM BOARD CEILINGS, LIGHT FIXTURES, ETC.
- 15. DEMOLISH CONSTRUCTION INDICATED OR REASONABLY IMPLIED TO BE REMOVED. LEAVE EXISTING CONSTRUCTION INTACT AND UNDAMAGED.
- THE EXTENTS OF WORK CAUSED BY THE DEMOLITION OPERATIONS.

 17. REMOVE EXISTING FLOOR FINISHES, ADHESIVE. PATCH AND REPAIR EXISTING FLOOR TO ACCOMMODATE NEW FLOOR FINISHES. PREPARE FLOOR SURFACE PER MANUFACTURER'S
- RECOMMENDATIONS FOR FLOORING BEING INSTALLED AND FOR THE INSTALLATION OF THE RADIANT HEATING SYSTEM.

 18. TAKE ALL NECESSARY PRECAUTIONS DURING DEMOLITION AND CONSTRUCTION TO PROTECT

PATCH, REFINISH, REPAIR, OR REPLACE IN KIND DAMAGED AREAS INCLUDING AREAS OUTSIDE

- AND MAINTAIN THE INTEGRITY AND OPERATION OF EXISTING OR TEMPORARY LIFE SAFETY AND EMERGENCY EGRESS AREAS AND SYSTEMS AS REQUIRED BY LOCAL BUILDING CODES.
- 19. TAKE ALL NECESSARY PRECAUTIONS TO PREVENT STRUCTURAL AND OTHER DAMAGE TO THE BUILDINGS EXISTING WALLS AND FINISHES.
 20. REMOVE ALL DEMOLITION AND CONSTRUCTION DEBRIS GENERATED FROM THE WORK OF THIS
- CONTRACT TO PREVENT THE OVERLOADING OF THE EXISTING FLOOR ASSEMBLY AND PROTECTION OF ADJACENT EXISTING CONSTRUCTION.
- 21. REMOVE DEBRIS AND WASTE DAILY FROM THE PROJECT SITE OR PLACE IN PROJECT DUMPSTER AT END OF EACH DAY.
- 22. PROPERLY DISPOSE OF ALL ITEMS INDICATED FOR REMOVAL AND DEMOLITION BUT NOT DESIGNATED FOR SALVAGE OR REUSE.

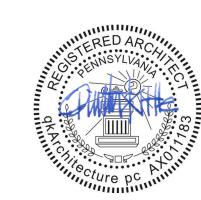

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5 PPG LOBBY RENOVATION

5 PPG PLACE PITTSBURGH, PA 15222

PROJECT NO. 396

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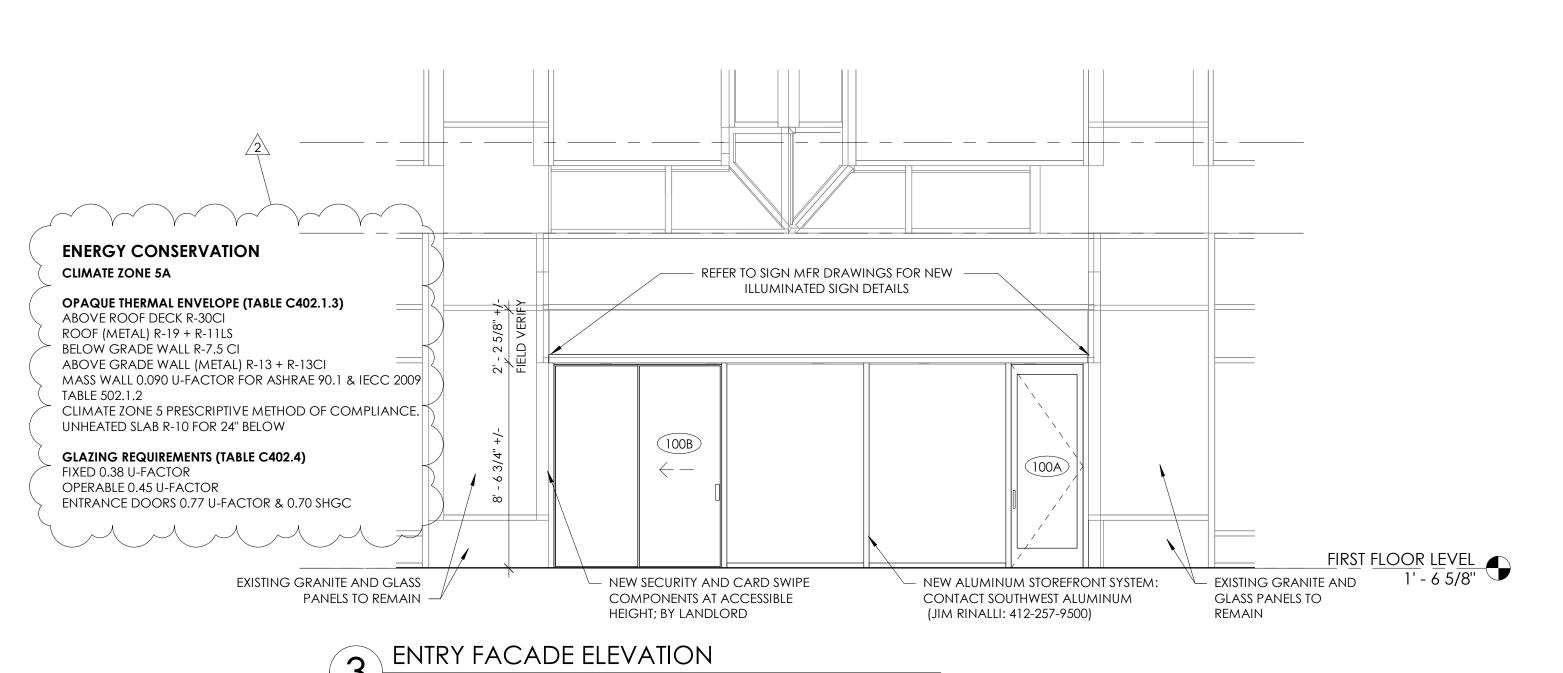
SHEET TITLE

DEMOLITION

UEET NO

PLAN

AD101
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MODEL

WATTS COMMENTS

TYPE MARK

DESCRIPTION

LIGHTING FIXTURE SCHEDULE

MANUFACTURER

1/4" = 1'-0"

DESCRIPTION

TYPE MARK

PLAN

1/4" = 1'-0"

| DOOR SCHEDULE | | | | | | | | | |
|---------------|-----------|------------|-------------|----------|--|--|--|--|--|
| MARK | DOOR TYPE | DOOR WIDTH | DOOR HEIGHT | HARDWARE | NOTES | | | | |
| | | | | | | | | | |
| 100A | G1 | 3' - 0'' | 8' - 6" | 1 | EMERGENCY EGRESS DOOR | | | | |
| 100B | G2 | 7' - 0'' | 8' - 6" | 2 | HORTON PROFILER SERIES 200B BELT DRIVE, SINGLE OPENING, FULL BREAKOUT TYPE 310. FINISH: MATCH STOREFRONT FINISH | | | | |
| 103 | HM2 | 3' - 0" | 8' - 6'' | | EXISTING DOOR | | | | |
| 107 | HM2 | 3' - 0'' | 8' - 6'' | | EXISTING DOOR | | | | |

DOOR HARDWARE

HARDWARE SETS

MASTER KEYWAY

COMMENTS

SUPPLIER

| MANUFACTURERS |
|--------------------------------|
| HINGES: HAGER |
| LOCKSETS, LATCHSETS: HAGER |
| CLOSERS: HAGER |
| PANIC DEVICES: FALCON |
| PUSH, PULL, KICK PLATES: HAGER |
| STOPS, BOLTS: HAGER |

THRESHOLDS, WEATHERSTRIPS: NATIONAL GUARD FINISH US26D (SATIN CHROME); US32D (STAIN STAINLESS);

MODEL

FIRST FLOOR PROPOSED PLAN

KEYING NEW MASTER KEYS 3 KEYS PER LOCK; 6 MASTER KEYS

SUPPLY DIFFUSER SCHEDULE

MANUFACTURER

CLOSERS SPRAYED TO MATCH

1 LOCKSET STORAGE FUNCTION 1 CYLINDER FRAME BUMPERS

FOR EXISTING SECURITY SYSTEM

HARDWARE BY THE ALUMINUM DOOR

HARDWARE BY SLIDING DOOR SUPPLIER

PROVIDE DOOR WITH OPEN PROTOCOL

PROVIDE CYLINDER KEYED TO LANDLORD'S

SET #4
ALL EXISTING HARDWARE TO REMAIN, CLEAN, ADJUST EXISTING

CODED NOTES - FLOOR PLAN

1 WOOD VENEER AND BACK-PAINTED GLASS PANEL SYSTEM.

2 NEW RECESSED MAILBOXES TBD. 3 NEW ALUMINUM STOREFRONT SYSTEM; COORDINATE NEW PROFILE WITH SOUTHWEST

ALUMINUM.

NEW GLASS DOOR WITH EMERGENCY EGRESS HARDWARE.

4 NEW GLASS SLIDER DOOR AND THRESHOLD.

6 INSTALL HEAT TRACE AND REINSTALL EXTERIOR GRANITE TILE.*

RECESSED TV DIRECTORY. SPEC BY OWNER, COORDINATE SIZE WITH PANEL CUTOUT. 8 HIGH RECEPTACLE. COORDINATE LOCATION WITH OWNER. STAINLESS FACE PLATE.

9 NEW SECURITY CAMERA. COORDINATE WITH SECURITY INSTALLER AND OWNER. 10 NEW ALUMNIUM CLADDING: SOUTHWEST ALUMINUM.

11 RELOCATED EXISTING OUTGOING MAIL BOX

DOOR GENERAL NOTES

LOCKSETS: SARFIENT ASSA ALLOY 82 MORTICE

W/ CITATION LEVER

CYLINDER LANDLORD BUILDING STANDARD: ASSA ABLOY VOLO

PROVIDE DELTA-THERM SNOW MELTING 27 WATTS, TWO CONDUCTOR M.I. HEATING CABLE

WITH HPDE OVER JACKET 6 INCHES ON CENTER AT ENTRANCE. REMOVE EXISTING STONE ENTRANCE TILING AND INSTALL SNOW MELTING SYSTEM PER


MANUFACTURER'S PRINTED INSTRUCTIONS.

PROVIDE INDICATOR AND TIMER PANEL IN LOCATION DETERMINED BY LANDLORD. PROVIDE CABLE ASSEMBLY BASE KIT AND ASSEMBLY ACCESSORIES, EMBEDDED PLATE MARKER RECOMMEND BY MANUFACTURE FOR FULLY COMPLETE AND OPERATIONAL

PROVIDE SPLICE KIT AS NECESSARY.

PROVIDE CONTROLLER MODEL GFPE RELAY COUNT AS REQUIRED FOR LENGTHS OF TRACE DETERMINED BY FIELD CONDITIONS. PROVIDE 30 AMP ELECTRICAL CIRCUIT OF SIZE AS REQUIRED FOR FINAL SYSTEM.

COORDINATE LOCATION OF AVAILABLE PANELBOARD WITH LANDLORD. PROVIDE DANFOSS LX205T WIFI THERMOSTAT. COORDINATE LOCATION WITH LANDLORD.

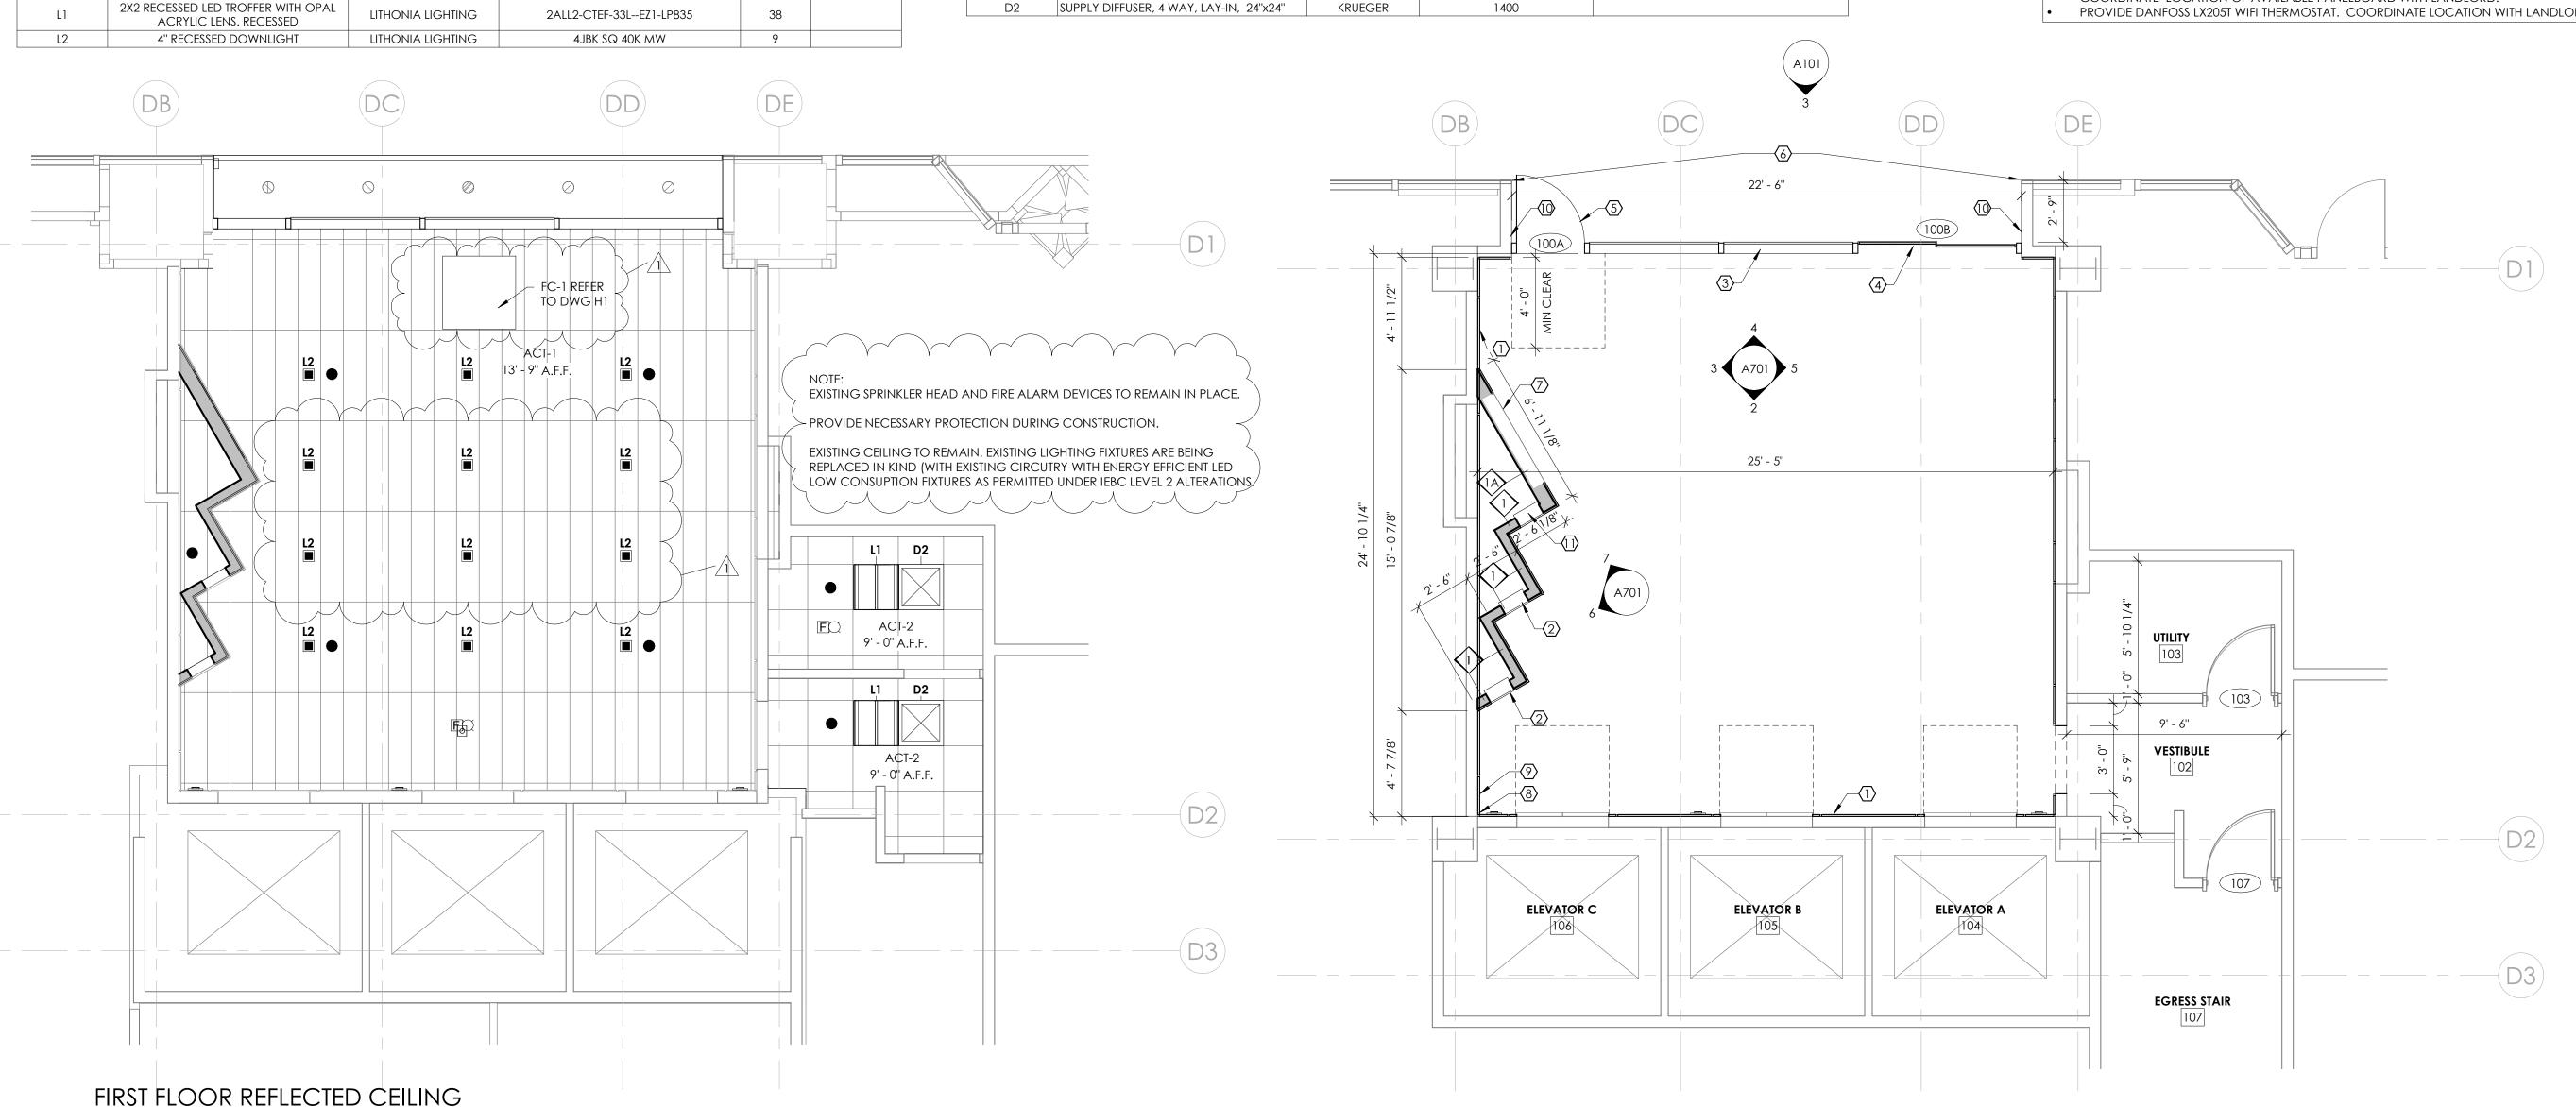



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> PLI COMMENTS REVISIONS

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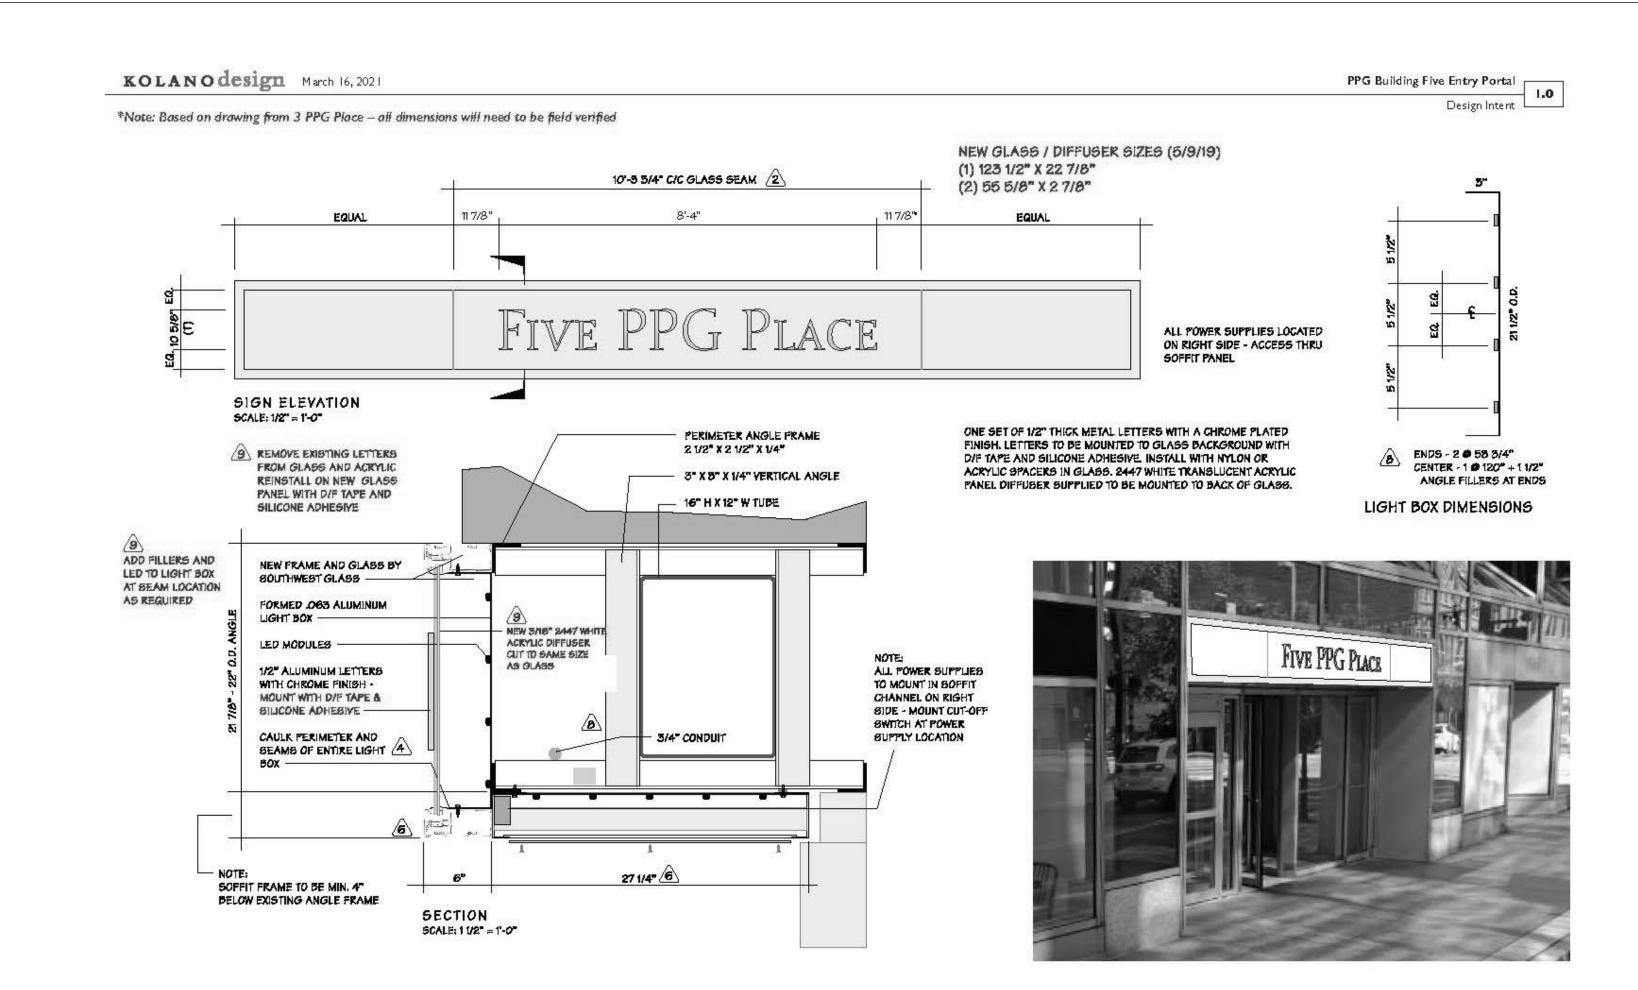
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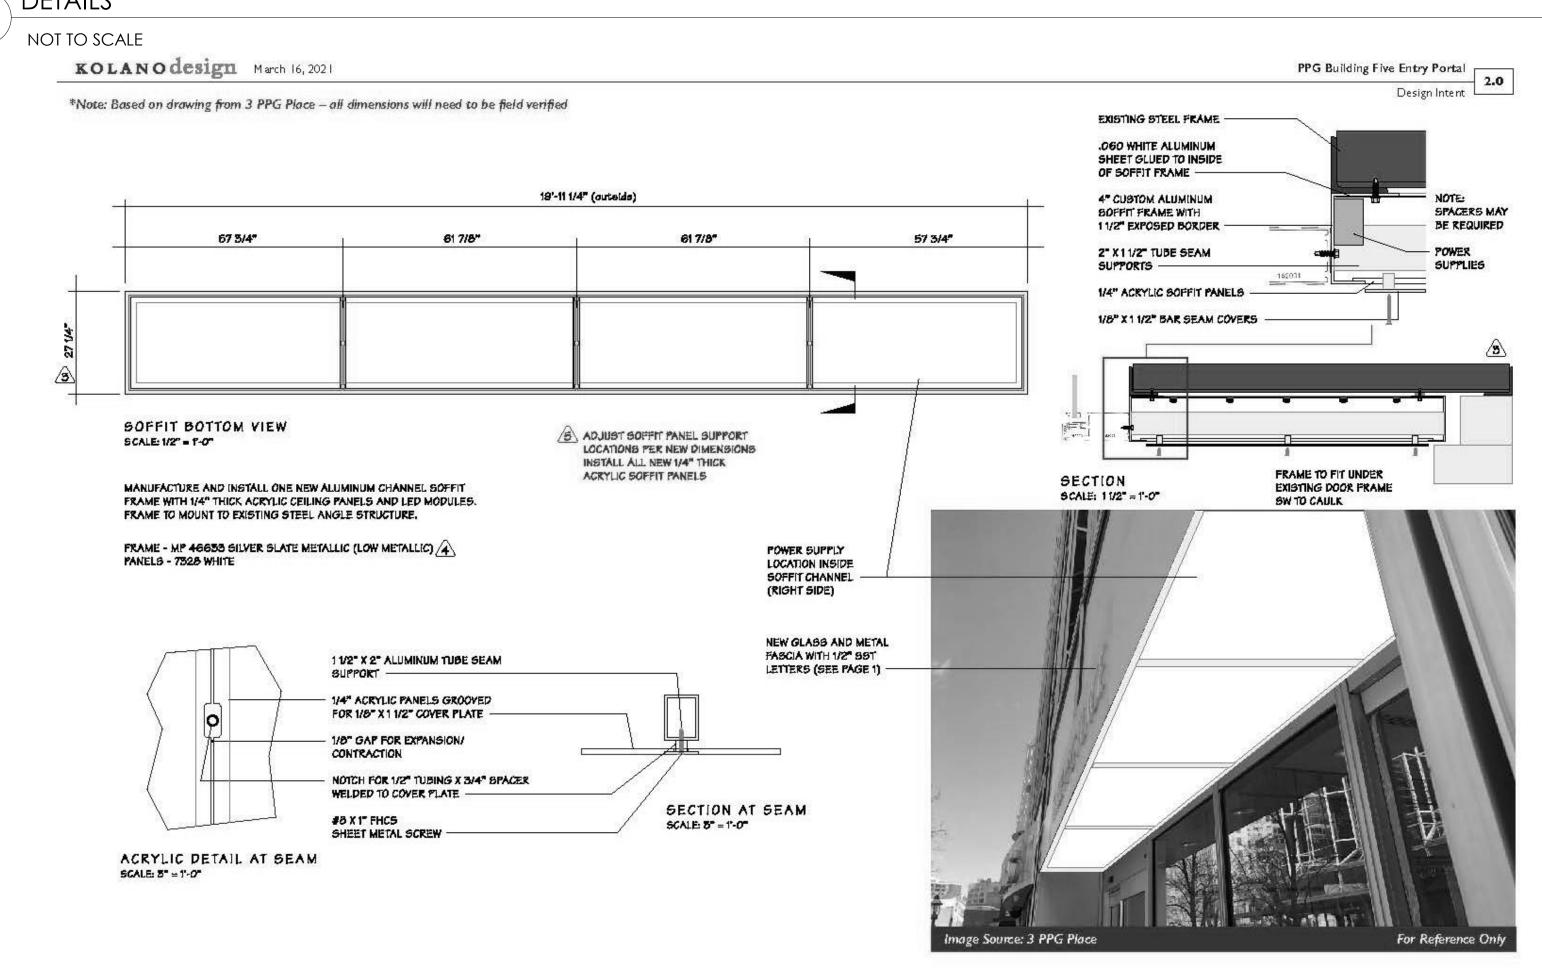
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FLOOR PLAN & REFLECTED CEILING PLAN


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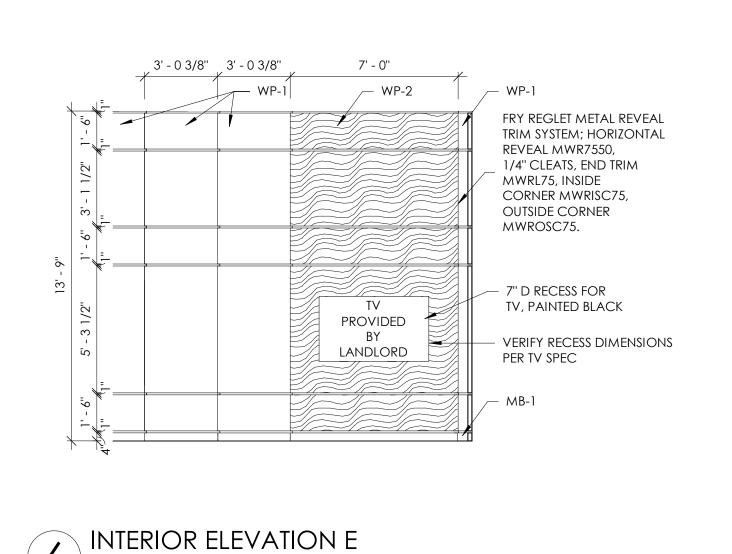
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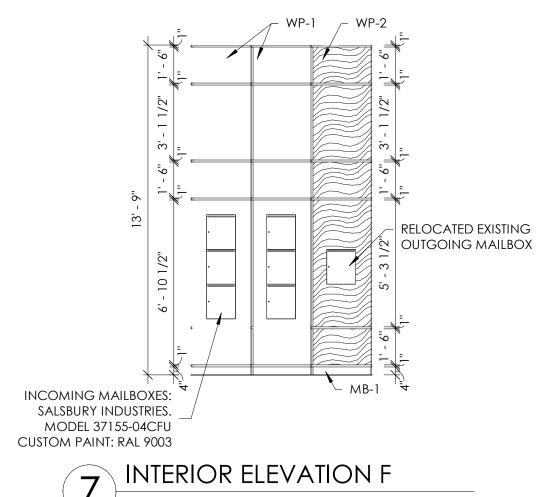
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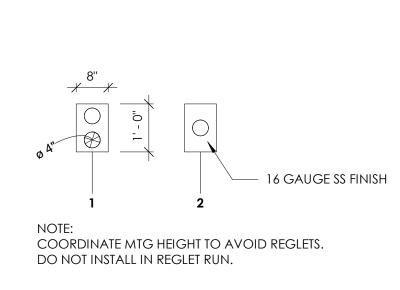
SHEET TITLE

EXTERIOR SIGNAGE AND DETAILS

A200
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| TYPE MARK | DESCRIPTION | MANUFACTURER | MODEL/ COLOR | | | | |
|-----------------------|--|----------------------|--------------------------------|--|--|--|--|
| | | | | | | | |
| CEILING | | | | | | | |
| ACT-1 | 1X4 CEILING, BEVELED, TEGULAR W/ 9/16" GRID | ARMSTRONG | DUNE 1775 | | | | |
| ACT-2 | 2x2 CEILING, BEVELED, TEGULAR W/ 9/16" GRID | ARMSTRONG | DUNE 1775 | | | | |
| LOORING | | | | | | | |
| CPT-1 | CARPET TILE, 24" X 24" | | | | | | |
| т 1 | DODOELAINI THE | CERAMICHE | INNER LAKE GRIP 18 X 36; GROUT | | | | |
| T-1 | PORCELAIN TILE | CAESAR | TBD BY OWNER | | | | |
| VCT-1 | VINYL COMPOSITION TILE, 12" X 12" | CAESAR ARMSTRONG | TBD BY OWNER TBD | | | | |
| | | | | | | | |
| VCT-1 | VINYL COMPOSITION TILE, 12" X 12" | ARMSTRONG | TBD | | | | |
| VCT-1 PAINT PT-1 | VINYL COMPOSITION TILE, 12" X 12" FIELD PAINT | ARMSTRONG PPG PAINTS | TBD TBD TBD | | | | |
| VCT-1 PAINT PT-1 PT-2 | VINYL COMPOSITION TILE, 12" X 12" FIELD PAINT | ARMSTRONG PPG PAINTS | TBD TBD | | | | |

FINISH SCHEDULE


FINISH SCHEDULE NOTES:

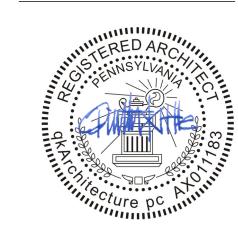
WP-2 WOOD VENEER PANEL

FOR WP-2 DO NOT SURFACE NAIL PANELS

FOR WP-1 WHITE BACK PAINTED GLASS, 1/4" TEMPERED GLASS ON PLYWOOD PANELS WITH FRY REGLET METAL REVEAL TRIM SYSTEM; HORIZONTAL REVEAL MWR7550, 1/4" CLEATS, END TRIM MWRL75, INSIDE CORNER MWRISC75, OUTSIDE CORNER MWROSC75.


TBD, REAR MOUNTED

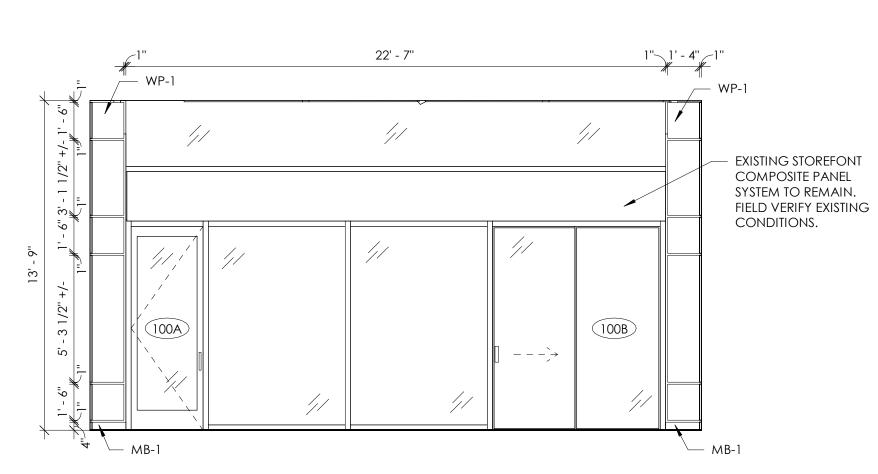


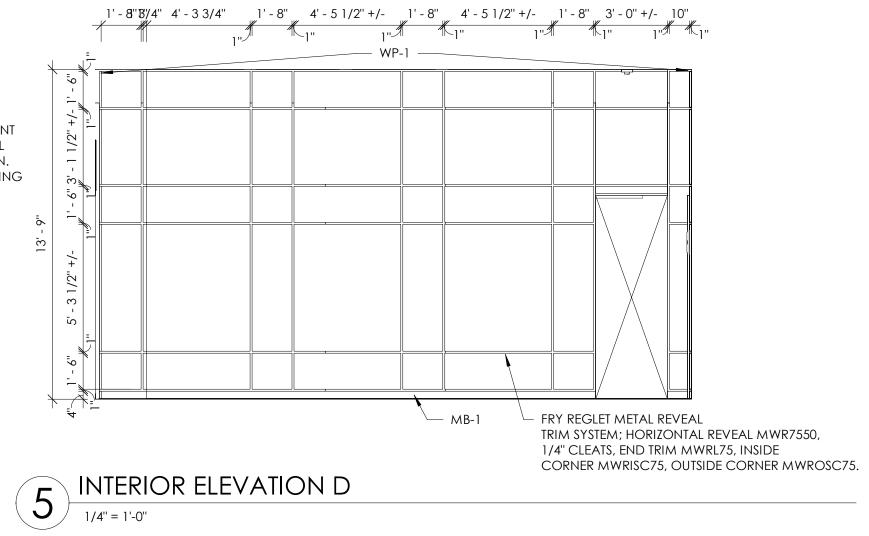


1' - 2 3/4" 4' - 8 1/2" 4' - 1 1/2"



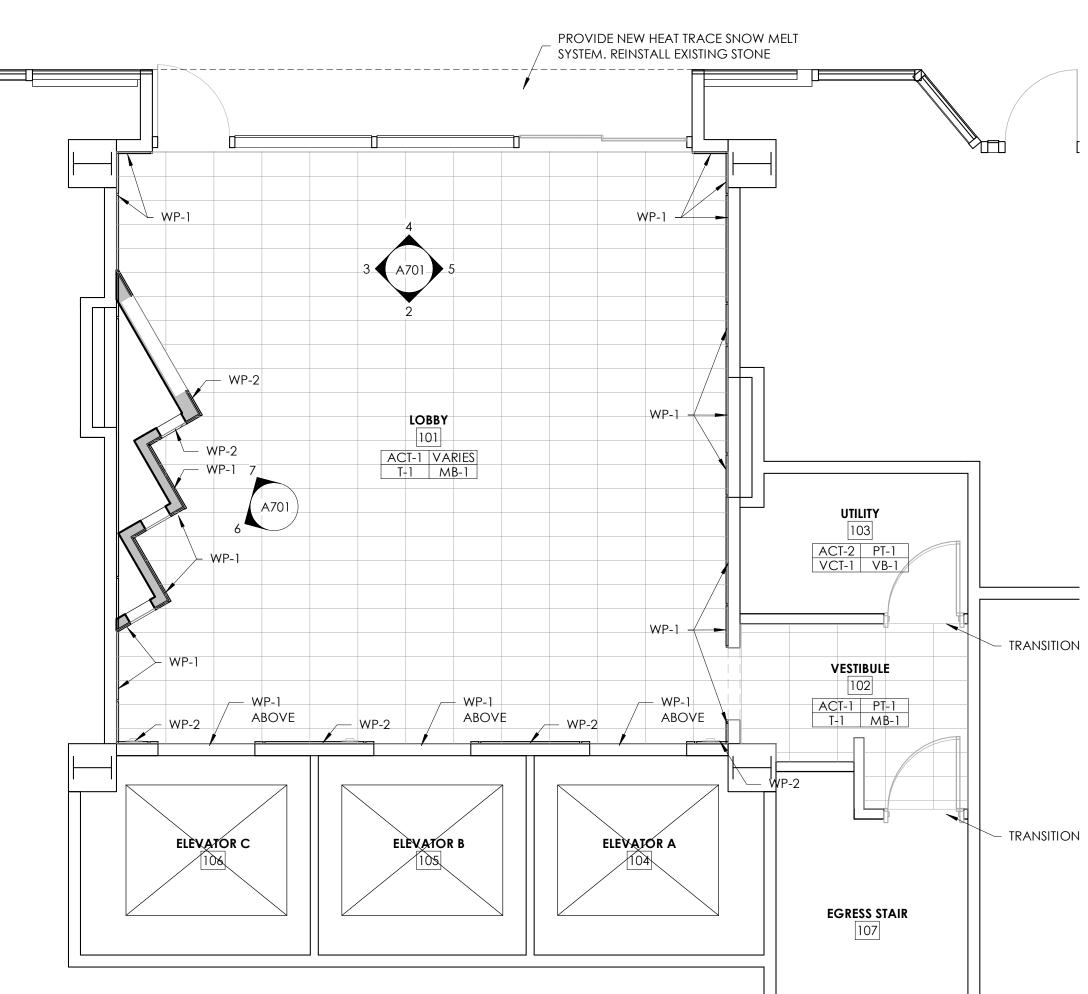

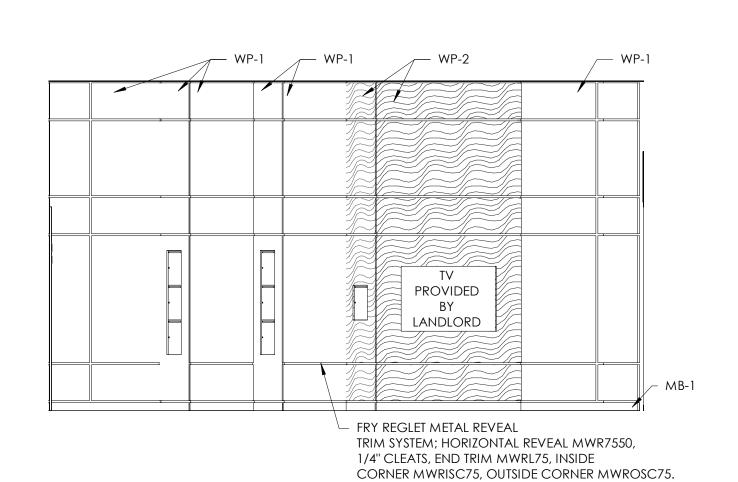

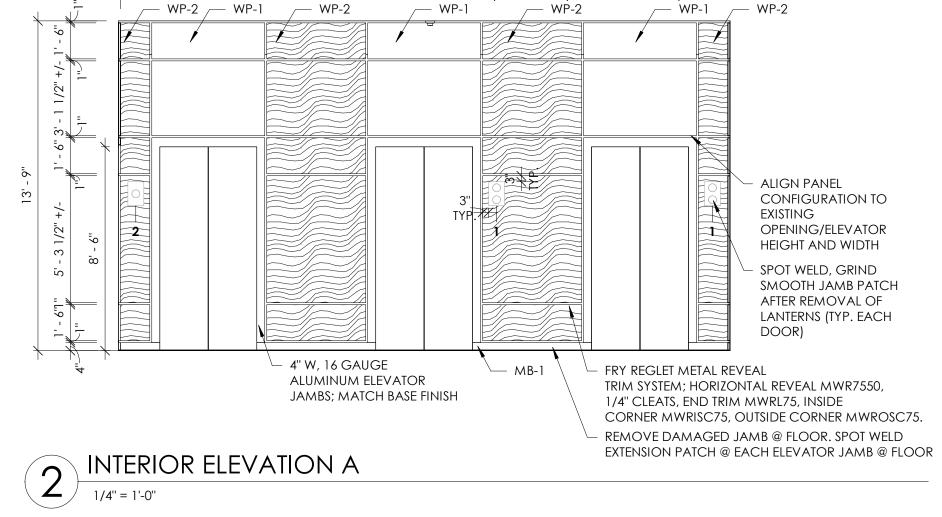

4' - 8 1/2''

4' - 1 1/2"

FIRST FLOOR FINISH PLAN

3 INTERIOR ELEVATION B

INTERIOR ELEVATION C

1/4" = 1'-0"



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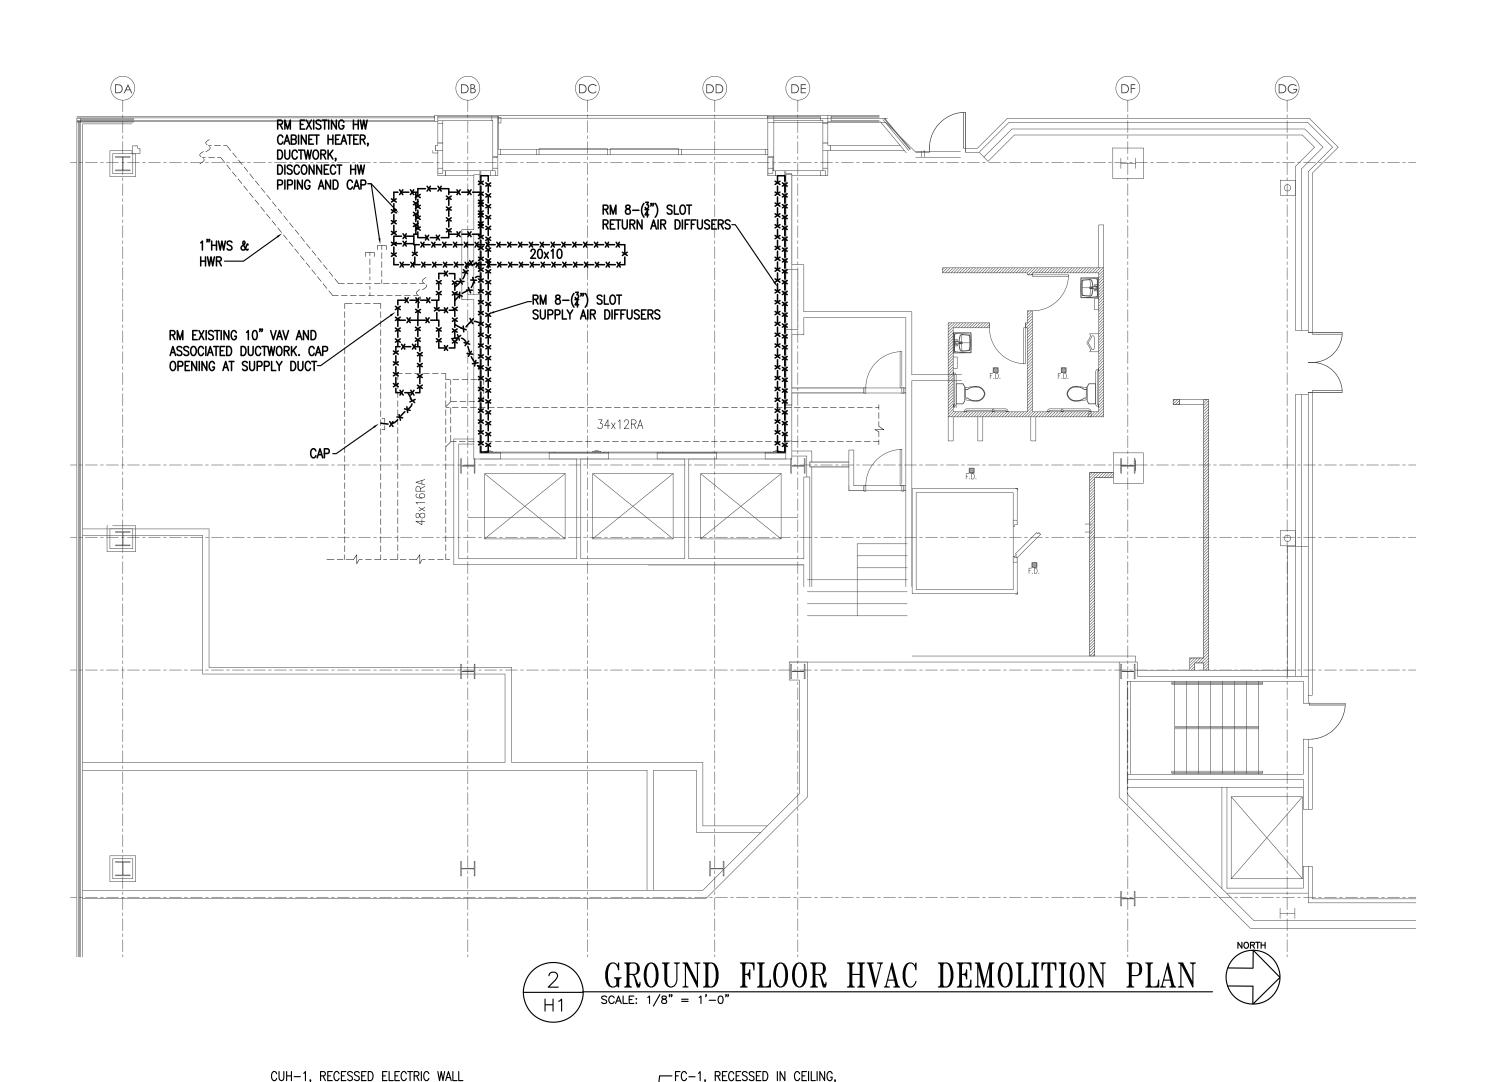
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RENOVATION

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FINISH PLAN & INTERIOR **ELEVATIONS**



HVAC SYMBOLS/ABBREVIATIONS

EXISTING DUCTWORK ~~~~~~~ EXISTING DUCTWORK TO BE REMOVED -x-x-x-x-x- EXISTING DUCTWORK TO BE REMOVED \bigcirc NEW THERMOSTAT

NEW CONTROL WIRING CONNECTION, NEW TO EXISTING NEW REMOVE

RELOCATE RELOCATED EXST. EXISTING

HVAC GENERAL NOTES


- 1. ALL WORK OF ALL TRADES SHALL BE DONE UNDER ONE CONTRACT BETWEEN THE OWNER'S REPRESENTATIVE AND THE HVAC CONTRACTOR WHO IS RESPONSIBLE FOR HIRING ALL REQUIRED SUB-CONTRACTORS FOR THIS PROJECT.
- 2. FIELD VERIFY ALL EXISTING CONDITIONS AT THE SITE BEFORE PROCEEDING WITH THE WORK.
- 3. LISTED DUCT SIZES INDICATE THE FREE INSIDE AREA REQUIRED. FIRST NUMBER IS THE SIDE BEING VIEWED. EQUIVALENT ROUND SIZES MAY BE USED. MAKE ALLOWANCES FOR DUCT LININGS REQUIRED.
- 4. PROVIDE SLEEVES AND FIRE STOP SEALANTS AT ALL PENETRATIONS THROUGH FIRE RATED WALLS AND FLOORS. FIRE STOPPING SHALL COMPLY WITH THE REQUIREMENTS OF ASTM E-814 AND UL 1479. ALL WALLS AROUND THE STAIRWELLS, ELEVATOR SHAFTS, ELECTRIC, AND MAIN EGRESS CORRIDORS HAVE A ONE OR TWO HOUR FIRE RATING. ALL FLOORS HAVE A TWO HOUR FIRE RATING.
- 5. THE HEATING CONTRACTOR SHALL PROVIDE ALL CONTROL DEVICES AND CONTROL WIRING. THE ELECTRICAL REQUIREMENTS OF THE CONTROL WIRING INSTALLATION SHALL MEET THE CURRENT EDITION OF THE NEC (NFPA 70).
- 6. PROVIDE ACCESS DOORS IN DUCTWORK AND FURNISH ACCESS DOORS FOR INSTALLATION IN DRYWALL CEILINGS AND WALLS TO THE GC TO PERMIT ACCESS TO ALL CONCEALED ITEMS IN NEED OF ADJUSTMENT. COORDINATE ACCESS DOOR PLACEMENT AND LOCATION WITH THE BUILDING ENGINEER.
- 7. BALANCE SYSTEM TO AIR QUANTITIES SHOWN ON PLAN. SUBMIT FINAL AIR BALANCE REPORT TO ENGINEER FOR REVIEW. INCLUDE FINAL AIR FLOW OBTAINED AT EACH AIR INLET AND OUTLET AND FINAL CFM AND STATIC PRESSURE AT FAN-COIL AND FURNACE.
- 8. THE DRAWINGS ARE DIAGRAMMATIC AND INTENDED TO SHOW THE GENERAL LAYOUT OF DUCTWORK, DIFFUSERS, CONTROLS AND PLANNED OPERATION. FIELD VERIFY ALL ROUTINGS AND ACTUAL FIELD CONDITIONS AT THE SITE PRIOR TO PROCEEDING WITH THE WORK. CAREFULLY COORDINATE ALL MECHANICAL WORK WITH OTHER TRADES AND EXISTING CONDITIONS.
- 9. SUBMIT SHOP DRAWINGS TO THE OWNER AND ENGINEER FOR REVIEW. SUBMITTALS SHALL INCLUDE CATALOG NUMBERS, CUTS. DIAGRAMS. AND OTHER DESCRIPTIVE DATA FOR ALL EQUIPMENT AND MATERIALS TO BE FURNISHED.
- 10. THERMOSTATS SHALL BE MOUNTED AT 44 INCHES ABOVE THE FINISHED FLOOR OR WHEN IN CLOSE PROXIMITY, ALIGN WITH WALL SWITCHES. THE INSTALLATION MUST MEET ADA MOUNTING HEIGHT AND ACCESSIBILITY REACH REQUIREMENTS.
- 11. INDIVIDUALLY MOUNTED MANUAL MOTOR STARTERS, FUSED DISCONNECT SWITCHES, NON-FUSED DISCONNECT SWITCHES, COMBINATION MOTOR STARTERS, AND VARIABLE FREQUENCY DRIVES FOR MOTOR DRIVEN HVAC EQUIPMENT SHALL BE FURNISHED BY THE HVAC CONTRACTOR. THE ELECTRICAL CONTRACTOR SHALL MOUNT THE DEVICES AND PROVIDE THE POWER WIRING THROUGH THE DEVICES TO THE MOTORS AND MAKE ALL FINAL TERMINATIONS. THE ELECTRICAL CONTRACTOR IS RESPONSIBLE FOR CORRECT ROTATION OF ALL MOTOR DRIVEN EQUIPMENT AND SHALL ASSIST THE HC IN STARTUP PROCEDURES.
- 12. DUCTWORK FABRICATION SHALL BE GALVANIZED SHEET METAL TO MEET ASHRAE AND SMACNA STANDARDS, 2" PRESSURE CLASSIFICATION.
- 13. ALL 90 DEGREE RECTANGULAR ELBOWS IN DUCTWORK SHALL HAVE TURNING VANES.
- 14. ALL MATERIALS, EQUIPMENT AND LABOR SHALL BE GUARANTEED BY THE CONTRACTOR FOR A PERIOD OF ONE YEAR AFTER FINAL COMPLETION.
- 15. THE ENTIRE INSTALLATION SHALL COMPLY WITH ALL APPLICABLE CODES AND REGULATIONS.
- 16. ALL INSULATION SHALL HAVE A MAXIMUM FLAME SPREAD/SMOKE DEVELOPED RATING OF 25/50 IN ACCORDANCE WITH NFPA 90A AND ASTM
- 17. ALL SHEET METAL DUCT SHALL BE INSULATED. PROVIDE 1.5 INCH THICK 2# DENSITY DUCT WRAP ON THE SUPPLY AND RETURN DUCTWORK.


| AIR COOLED HEAT PUMP UNIT SCHEDULE | | | | | | | | | | | | | | | | | | | |
|------------------------------------|-----|--|-----------|--|----------|---------|--------|---|------|----|---|-----|-----|--------------|---------------|-------|----------|------|-------------------------|
| TAG NO. | MBH | COOLING (95AMB) HEATING MBH SUCT. T. SEER/IEER STAGES MBH(47/17/5) HSPF/COP | | | | REFRIG. | COMPR. | ELECTRICAL COMPR. RLA(EA) LRA(EA) FANS (WATTS) FLA(EA) V/PH/HZ MCA MFA | | | | | | MFA | SIZE WxDxH | WGHT. | REMARKS | | |
| HP-1 | 42 | 44 | 16.3/10.7 | | 45/30/30 | 9.8/3.3 | | | 20.0 | 28 | 2 | 172 | 0.8 | 208/230/1/60 | 26 | 40 | 37x14x53 | 251# | MITSUBISHI PUZ-HA42NKA1 |

| | FAN COIL UNIT SCHEDULE — HEAT PUMP | | | | | | | | | | | | | | | | | | |
|---------|------------------------------------|------|------|-------------|---------|-----|---------------|------------|------------|--------------|----------|-------------------|-----------|----------|----------------|----|------------|---------|-----------------------|
| TAG NO. | CFM | FAN | CLG | CLG SMBH | EAT/LAT | T22 | COIL ROWS/ | HTG MBH | REFRIG. | ELI | ECTRICAL | /10000I/(1ED 01EE | | | WGHT. | AU | X ELECTRIC | HEAT | REMARKS |
| IAG NO. | HI/LO | H.P. | TMBH | SMBH | | 331 | FINS | MBH | INLI INIO. | V/PH/HZ | MCA | MFA | HEAT PUMP | WxDxH | W OIII. | KW | STAGES | V/PH/HZ | ILIMAINO |
| FC-1 | 1090/ 780 | 0.16 | 42 | 30 | 80/67 | 45 | 3/18 | 45/30 | R410a | 208/230/1/60 | 2.0 | 15 | HP-1 | 33x33x13 | 56# | | | | MITSUBISHI PLA-A42EA7 |
| | | | | | | | | | | | | | | | | | | | |


PROVIDE TXV SUITABLE FOR HEAT PUMP DUTY.

- PROVIDE FIELD INSTALLED PRE-CHARGED REFRIGERANT PIPING SETS.
- PROVIDE REMOTE ROOM TEMPERATURE SENSOR AND PROGRAMMABLE THERMOSTAT SUITABLE FOR HEAT PUMP DUTY, AUXILIARY CONTACTS FOR ELECTRIC HEAT
- PROVIDE SINGLE POINT ELECTRICAL CONNECTIONS.
- PROVIDE AUTOMATED LOGIC TEMPERATURE SENSOR CONNECTED TO BUILDING'S BAS ADJACENT TO THERMOSTAT TO MONITOR SPACE.
- PROVIDE FAN COIL UNIT WITH INTEGRAL CONDENSATE PUMP & 1" COND DRAIN.

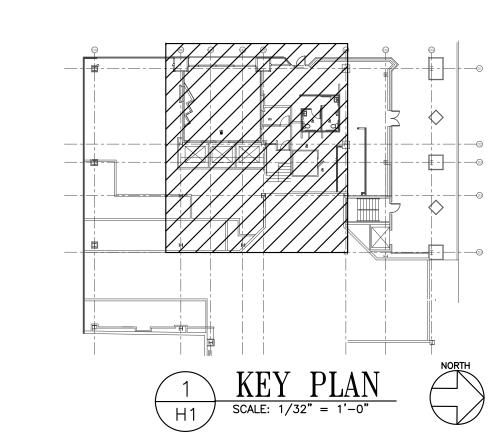

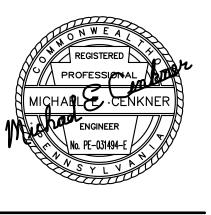

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PROJECT TITLE 5 PPG LOBBY RENOVATION

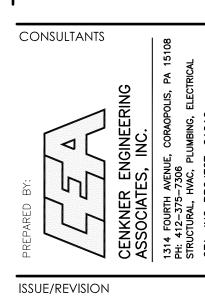5 PPG PLACE PITTSBURGH, PA 15222

| PROJECT NO. | 396 |
|-------------|------------|
| ISSUE DATE | 01/15/2021 |
| SHEET TITLE | |

HVAC DEMOLITION, NEW PLANS, SCHEDULES AND NOTES

SHEET NO.

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